

ABBREVIATIONS

AC - ACRES
 BLDG - BUILDING
 BOT - BOTTOM
 BW - BOTTOM OF WALL
 C - CURVE
 CB - CATCH BASIN
 CF - CUBIC FEET
 CI - CAST IRON
 CL - CENTERLINE
 CD - CLEAN OUT
 CONC - CONCRETE
 CMP - CORRUGATED METAL PIPE
 CPP - CORRUGATED PLASTIC PIPE
 DA - DELTA ANGLE
 DA# - DRAINAGE AREA #
 DI - DUCTILE IRON
 DIA - DIAMETER
 DWG - DRAWING
 E - EAST
 EG - EXISTING GRADE
 EL - ELEVATION
 ESC - EROSION & SEDIMENT CONTROL
 FF - FINISHED FLOOR
 FG - FINISH GRADE
 GV - GATE VALVE
 HDPE - HIGH DENSITY POLYETHYLENE PIPE
 HYD - HYDRANT
 IPF - IRON PIPE FOUND
 IPS - IRON PIPE SET
 INT - INTERSECTION
 INV - INVERT
 L - LENGTH
 LF - LINEAR FEET
 MAX - MAXIMUM
 MIN - MINIMUM
 N - NORTH
 NO./# - NUMBER
 NTS - NOT TO SCALE
 NYSDEC - NEW YORK STATE DEPARTMENT OF ENVIRONMENTAL CONSERVATION
 NYSDOT - NEW YORK STATE DEPARTMENT OF TRANSPORTATION
 NYSDOH - NEW YORK STATE DEPARTMENT OF HEALTH
 OHW - OVERHEAD WIRE
 PC - POINT OF CURVATURE
 PCC - POINT OF COMPOUND CURVE
 PT - POINT OF TANGENCY
 PVC - POLYVINYL CHLORIDE PIPE
 R - RADIUS
 RCP - REINFORCED CONCRETE PIPE
 ROC - RUN OF CRUSHER
 ROW - RIGHT-OF-WAY
 S - SOUTH
 SAN - SANITARY
 SDR - STANDARD DIMENSION RATIO
 SNMH - SANITARY MANHOLE
 STMH - STORM MANHOLE
 SWPPP - STORM WATER POLLUTION PREVENTION PLAN
 TC - TIME OF CONCENTRATION
 TL - TANGENT LENGTH
 TYP - TYPICAL
 TW - TOP OF WALL
 TS & V - TAPPING SLEEVE & VALVE
 UNO - UNLESS NOTED OTHERWISE
 W - WEST

MASTER LEGEND

LEGEND:	EXISTING	PROPOSED	CONCEPTUAL
5' CONTOUR			
1' CONTOUR			
BUILDING			
BUSH			
CATCH BASIN			
CENTERLINE			
CITY MONUMENT			
CLEANOUT			
CONCRETE SIDEWALK			
CONIFEROUS TREE			
CURB STOP			
CURBED ROAD			
DECIDUOUS TREE			
EDGE OF PAVEMENT			
ELECTRICAL BOX			
ELECTRIC MANHOLE			
FENCE			
FIRE HYDRANT			
FLOWERING PLANTINGS			
GAS LINE			
1/2" IRON PIPE WITH CAP SET			
IRON PIPE FOUND (AS NOTED)			
LIGHT POLE			
PROPERTY LINE			
SEWER LINE			
SEWER MANHOLE			
SIGNS			
SILT FENCE			
SOLID WHITE LANE LINE			
STORM LINE			
STORM MANHOLE			
TREELINE			
UNDERGROUND ELECTRIC			
UTILITY POLE & GUY WIRE			
WATER LINE			
WATER OUTLINE			
WATER VALVE			
WETLANDS			
BOLLARD			
WATERLINE CROSSING			

SIGN SCHEDULE

LABEL	SIGNS	LABEL	SIGNS
A		E	
B		F	
C		G	
D			

SIGNAGE NOTES

- ALL OUTSIDE SIGNS ARE TO BE CONSTRUCTED IN ACCORDANCE WITH ALL DETAILS WITHIN THE STATE OF NEW YORK DEPARTMENT OF TRANSPORTATION - METRIC STANDARD SHEETS M645-20 THROUGH M645-80. THIS INCLUDES BUT IS NOT LIMITED TO: STANDARD SIGN BLANK DETAILS (M645-50 THROUGH M645-52); STANDARD HEIGHT AND LATERAL LOCATION FOR TRAFFIC SIGNS, TYPICAL REGULATION & WARNING SIGNS ASSEMBLED (M645-55); SIGN PANEL DETAILS FOR GUIDE, INFORMATION AND OTHER SIGNS (M645-70); BI- DIRECTIONAL BREAKAWAY BASE AND HINGE ASSEMBLY (M645-72).
- ALL SIGNS AND PAINT MARKINGS ARE TO BE INSTALLED IN ACCORDANCE WITH THE REQUIREMENTS AS OUTLINED IN THE LATEST VERSION OF THE FEDERAL MUTCD AND THE NYS SUPPLEMENT.

GENERAL NOTES

- UNDERGROUND FACILITIES, STRUCTURES AND UTILITIES HAVE BEEN PLOTTED FROM AVAILABLE SURVEYS AND RECORDS, AND THEREFORE THEIR LOCATIONS MUST BE CONSIDERED APPROXIMATE ONLY. THERE MAY BE OTHERS, THE EXISTENCE OF WHICH IS PRESENTLY NOT KNOWN. PRIOR TO CONSTRUCTION CONTACT UNDERGROUND UTILITIES CALL CENTER OF NEW YORK FOR EXACT LOCATION OF ALL UNDERGROUND UTILITIES, (1-800-962-7962). CONTRACTOR IS RESPONSIBLE FOR LOCATING AND WORKING WITH THE APPROPRIATE UTILITY COMPANIES PRIOR TO CONSTRUCTION.
- THE TOPOGRAPHIC SURVEY WITHIN ±50 FEET OF THE PROPOSED HOTEL WAS PERFORMED BY GYMO, P.C. WITHIN THE MONTH OF 12/2009. THE REMAINING SURVEY WAS DERIVED FROM PROPOSED PLANS WHICH HAVE BEEN PREVIOUSLY PREPARED BY GYMO, P.C.
- ALL OUT-OF-SCOPE AREAS DISTURBED BY THE CONTRACTOR'S OPERATIONS WILL BE RESTORED TO CONDITIONS EQUAL TO OR BETTER THAN THAT PRIOR TO CONSTRUCTION, OUTSIDE OF PROPERTY BOUNDARIES AND EASEMENT AREAS THE CONTRACTOR IS REMINDED TO OBTAIN WRITTEN AUTHORIZATION TO USE PRIVATE PROPERTY AND ASSUMES ALL LIABILITY WHEN ACCESSING THOSE PROPERTIES.
- THE CONTRACTOR IS RESPONSIBLE FOR VERIFYING THE CHARACTERISTICS AND EXTENT OF SUBSURFACE SOILS, ROCK, WATER TABLE LEVELS, ETC., PRIOR TO BIDDING.
- THE CONTRACTOR SHALL BE RESPONSIBLE FOR OBTAINING ALL PERMITS, SECURITY, BONDS, FEES, AND PAYMENTS TO OBTAIN SAID PERMITS WHERE APPLICABLE.
- WHEN THE PERFORMANCE OF THE CONTRACTOR'S WORK REQUIRES THE INTERRUPTION OF UTILITY SERVICES, HE/SHE SHALL ISSUE A 48 HOUR PRIOR NOTICE TO THE GOVERNING MUNICIPALITY.
- SITE CONTRACTOR TO PROVIDE EROSION AND SEDIMENT CONTROL AND DUST CONTROL.
- A LICENSED LAND SURVEYOR SHALL BE RETAINED FOR ALL UTILITY AND FIELD STAKEOUT AND AS-BUILTS AT THE CONTRACTOR'S EXPENSE.
- CONTRACTOR SHALL MAINTAIN ALL EROSION CONTROL MEASURES THROUGHOUT CONSTRUCTION UNTIL ESTABLISHMENT OF VEGETATIVE COVER. RUN-OFF CONTAINING SEDIMENTS FROM DISTURBED AREAS OF THE SITE SHALL NOT BE ALLOWED DIRECTLY OFF SITE OR INTO NATURAL STREAM CHANNELS.
- ALL EXISTING TREES TO REMAIN SHALL BE PROTECTED BY THE CONTRACTOR. CONSTRUCTION ACTIVITIES ADJACENT TO TREES SHALL BE CONDUCTED TO REDUCE THE IMPACT TO TREES TO THE MAXIMUM EXTENT PRACTICAL. ANY DAMAGE TO EXISTING TREES SHALL BE REPAIRED OR THE TREE REPLACED, AS DIRECTED BY THE OWNER AT THE CONTRACTOR'S EXPENSE.
- CONTRACTOR SHALL BE RESPONSIBLE FOR CLEARING, GRUBBING, CUTTING AND DISPOSING OF VEGETATION, TREES AND DEBRIS IN A NYSDEC ACCEPTABLE LOCATION.
- CONTRACTOR SHALL PERFORM ALL NECESSARY EARTHWORK, INCLUDING THE STRIPPING, STOCKPILING AND REPLACING OF TOPSOIL IN ACCORDANCE WITH THE PLANS. EXCESS MATERIAL SHALL BE REMOVED FROM THE SITE.
- EXCAVATIONS SHALL BE TO DEPTHS SHOWN ON DRAWINGS. ALL UNSTABLE OR UNSUITABLE MATERIAL SHALL BE EXCAVATED AND REMOVED TO SUCH DEPTH AS REQUIRED TO PROVIDE SUFFICIENT BEARING CAPACITY. OVER-EXCAVATED AREAS SHALL BE BACKFILLED WITH SUITABLE MATERIAL.
- COMPACTION OF PIPE BEDDING AND BACKFILL MATERIAL SHALL BE BY MEANS OF HAND-GUIDED POWER DRIVEN, DRUM-TYPE, OR PLATE TAMPERS. BACKFILLING SHOULD PROCEED IN ACCORDANCE WITH LIFT THICKNESSES AND COMPACTION REQUIREMENTS AS SHOWN ON THE DRAWINGS. UNLESS OTHERWISE NOTED ON THE DRAWINGS, COMPACTION REQUIREMENTS REFER TO PERCENT OF MAXIMUM DRY DENSITY AS DETERMINED IN ACCORDANCE WITH ASTM STANDARD D1557 METHOD "C". CARE SHALL BE TAKEN TO SHAPE PIPE BEDDING TO FIT THE LOWER PART OF THE PIPE. BACKFILLING AND COMPACTION SHOULD PROGRESS EVENLY ALONG THE PIPE SIDEWALLS AND TO THE TOP OF THE PIPE BEDDING.
- COMPACTION SHALL BE 90% MAXIMUM DRY DENSITY IN GRASS AREAS AND 95% MAXIMUM DRY DENSITY IN GRAVEL AREAS. MAXIMUM DRY DENSITY SHALL BE AS DETERMINED BY ASTM - D1557 MODIFIED PROCTOR, METHOD C. THE CONTRACTOR SHALL HIRE AN INDEPENDENT TESTING AGENCY TO PERFORM PAVEMENT TESTING PER TECHNICAL SPECIFICATIONS AND PROVIDE THE RESULTS TO THE OWNER AND CITY FOR REVIEW PRIOR TO FINAL PAYMENT.
- CONTRACTOR SHALL NOTIFY THE ENGINEER OF ANY DISCREPANCIES OF DIMENSIONS, ELEVATIONS AND LOCATIONS DURING PRECONSTRUCTION FIELD VERIFICATION, SUCH INFORMATION SHALL BE BROUGHT TO THE ATTENTION OF THE ENGINEER FOR VERIFICATION OR MODIFICATION OF THE PLANS.
- CONTRACTOR SHALL PROVIDE AS-BUILT RECORD DRAWINGS INCLUDING, AS A MINIMUM, THE FOLLOWING INFORMATION AS WELL AS ALL REQUIREMENTS OF THE SPECIFICATION:
 - RECORD OF ALL UTILITIES ENCOUNTERED IN TRENCH EXCAVATION. INFORMATION SHALL INCLUDE DIAMETER OF UTILITY, DEPTH OF BURIAL AND LOCATION WITH REFERENCE TO NEAREST STRUCTURE SHOWN ON DRAWINGS. THIS INFORMATION SHALL BE KEPT CURRENT ON A WEEKLY BASIS. FAILURE TO DO SO MAY RESULT IN WITHHOLDING OF PAYMENTS.
 - DISTANCE TIES TO ALL BENDS, VALVES, MANHOLES, CATCH BASINS, ETC.
 - UTILITY REPAIRS, SIDEWALK, AND DRIVEWAY REPLACEMENTS CENTERLINE.
 - RIM AND INVERT ELEVATIONS, AND HORIZONTAL LOCATION OF MANHOLES, CATCH BASINS, AND CLEANOUTS.
 - STATIONS OF BENDS AND VALVES.
 - DENOTED BENCH MARK REFERENCES USED.
 - PERIODIC OFFSETS.
 - RECORD DETAILS NOT SHOWN ON THE ORIGINAL CONTRACT DOCUMENTS. ANY FIELD CHANGES OF DIMENSIONS AND DETAILS AND ANY CHANGES MADE BY CHANGE ORDER OR FIELD ORDER.
 - CERTIFICATE OF SUBSTANTIAL COMPLETION SHALL NOT BE ISSUED UNTIL AS-BUILT INFORMATION IS ACCEPTABLE.
 - TWO (2) SETS OF FINAL COMPLETE RECORD DRAWINGS. CONTRACTOR SHALL FURNISH AS-BUILT DATA ON PLAN SHEETS.
- UPON COMPLETION OF STORM SEWER FACILITIES AND ESTABLISHMENT OF VEGETATION, THE NEW AND EXISTING STORM SYSTEMS RECEIVING RUNOFF FROM THIS SITE SHALL BE CLEANED OF DEBRIS. ONLY AT THIS TIME SHALL THE EROSION AND SEDIMENTATION CONTROL MEASURES BE REMOVED.
- CONTRACTOR SHALL PROVIDE SATISFACTORY DEWATERING AND DRAINAGE OF EXCAVATIONS. SEE DEWATERING AND DRAINAGE IN THE TECHNICAL SPECIFICATIONS FOR MORE DETAILED INFORMATION.
- A STORM WATER POLLUTION PREVENTION PLAN HAS BEEN PREPARED FOR THIS PROJECT. THE CONTRACTOR SHALL COMPLY WITH THE NYSDEC REQUIREMENTS WITHIN THIS REPORT.
- ALL WATERMAIN WORK IS TO BE COORDINATED WITH THE CITY OF WATERTOWN WATER DEPARTMENT. WATER DEPARTMENT REQUIREMENTS WILL SUPERCEDE ALL OTHER PLANS AND SPECIFICATIONS.
- PERMITS: THE FOLLOWING PERMITS MUST BE OBTAINED FROM THE ENGINEERING DEPARTMENT BEFORE THE START OF SITE CONSTRUCTION:
 - SANITARY SEWER LATERAL (COMMERCIAL) - \$ TO BE DETERMINED
 - CITY PERMIT - NO FEE
- PLEASE NOTE THAT ANY CONTRACTOR WORKING WITHIN THE CITY OF WATERTOWN MUST PROVIDE A CURRENT CERTIFICATE OF LIABILITY INSURANCE (ACORD 25). IN ADDITION, NYS ALSO MANDATES PROOF OF WORKER'S COMPENSATION BE SHOWN PRIOR TO THE ENGINEERING DEPARTMENT ISSUING ANY PERMITS.
- A PERMIT MUST BE OBTAINED FROM THE CITY OF WATERTOWN WATER DEPARTMENT TO COVER ANY WORK OR MATERIALS TO BE PROVIDED BY THE WATER DEPARTMENT, INCLUDING BUT NOT LIMITED TO THE TAP AT THE MAIN AND COORDINATION WITH TYING INTO THE MAIN WITHIN THE PROJECT AREA.
- THE CITY OF WATERTOWN WATER DEPARTMENT MUST BE PRESENT TO ASSIST WITH FLUSHING OF MAINS, WITNESSING OF PRESSURE TESTING, AND PERFORMING THE DISINFECTION. THE COST OF WORK PERFORMED BY THE WATER DEPARTMENT WILL BE PAID FOR BY THE CONTRACTOR UPON THE CITY PRESENTING AN INVOICE FOR SUCH WORK.
- THERE SHALL BE NO DEVIATION FROM THE SPECIFICATIONS FOR WATER MAIN AND SERVICE MATERIALS AND CONSTRUCTION. THIS INCLUDES, BUT IS NOT LIMITED TO, THE PLACING OF A MINIMUM OF THREE BRONZE WEDGES AT EACH PUSH-ON JOINT FOR CONTINUITY, PROPER BACKFILL PLACEMENT AND COMPACTION, AND PROPER PLACEMENT AND SIZING OF THRUST BLOCKS. ALL PIPE AND MATERIALS MUST BE MADE IN NORTH AMERICA, UNLESS OTHERWISE APPROVED, AND SHOP DRAWINGS OR CUT SHEETS FOR PIPE AND MATERIAL MUST BE APPROVED BY THE WATER DEPARTMENT.

GENERAL DEMOLITION NOTES:

- THE CONTRACTOR IS TO ACQUIRE ANY REQUIRED DEMOLITION PERMITTING FROM ALL INDIVIDUAL REGULATING AGENCIES, LOCAL AUTHORITIES, OR GOVERNMENTAL BODIES. THE CONTRACTOR WILL SUPPLY AND PAY FOR ALL EFFORT AND/OR EXPENSE ASSOCIATED WITH ACQUIRING SAID DEMOLITION PERMIT UNDER THIS CONTRACT.
- IT IS THE CONTRACTOR'S RESPONSIBILITY TO BE AWARE OF AND TO CONFORM WITH ALL RULES AND RESPONSIBILITIES ASSOCIATED WITH PROVIDING A SAFE WORK PLACE. THE CONTRACTOR MUST COMPLY WITH OSHA 29 CFR PART 1926, SAFETY AND HEALTH REGULATIONS FOR CONSTRUCTION, SPECIFICALLY SUBPART T - DEMOLITION, SUBPART Z-TOXIC AND HAZARDOUS SUBSTANCES, AND 1926.62 LEAD.
- PRESENCE OF HAZARDOUS MATERIALS SHALL BE BROUGHT TO THE OWNERS IMMEDIATE ATTENTION.
- DISPOSAL OF ALL CONSTRUCTION AND DEMOLITION DEBRIS SHALL BE IN ACCORDANCE WITH LOCAL AND 6 NYS CRR PART 360, PLUS OTHER APPLICABLE CODES. DISPOSAL SHALL BE AT THE CONTRACTOR'S EXPENSE.
- REMOVAL AREAS SHALL BE RESTORED IN ACCORDANCE WITH THE SITE, UTILITY, AND GRADING PLANS.

HILTON GARDEN INN PHOTOMETRICS

Luminaire Schedule					
Qty	Label	Arrangement	Lumens	LLF	Description
5	A-3HS	SINGLE	107800	0.580	AER-G-HR-III-1000MH-HS
3	A-5	SINGLE	107800	0.580	AER-G-HR-V-SQ-1000MH
1	A-3	SINGLE	107800	0.580	AER-G-HR-III-1000MH
4	B-5	SINGLE	9000	0.580	SIG-HR-V-SQ-100PSMH
4	C-2	SINGLE	9000	0.580	AER-II-100MH

PLANTING SCHEDULE

COMMON NAME	ABBREV.	BOTANICAL NAME	SIZE	QTY.
RED MAPLE	RM	ACER RUBRUM	2" CAL.	5
NORWAY MAPLE	NM	ACER PLATANOIDES	2" CAL.	4
CANADIAN HEMLOCK	CH	TSUGA CANADENSIS	4'-5' B.B.	8
AUSTRIAN PINE	AP	PINUS NIGRA	5-6' BB.	6
WHITE FIR	WF	ABIES CONCOLOR	4'-5' B.B.	8
COLORADO SPRUCE	CS	PICEA PUNGENS	5-6' BB.	8
DARK AMERICAN ARBORVITAE	DA	THUJA OCCIDENTALIS NIGRA 'DARK AMERICAN ARBORVITAE'	5-6' BB.	8
SKYLINE LOCUST	SL	GLEDTISIA TRIACANTHOS INERMIS 'SKYLINE'	2- 2 1/2' CAL.	5
DAY LILIES	DL	HEMEROCALLIS 'STELLA DE ORO'	1 GAL.	51
EMERALD GAIETY EUONYMUS	EE	EUONYMUS FORTUNEI 'EMERALD GAIETY'	2 GAL.	29
ANDORRA JUNIPER	AJ	JUNIPERUS HORIZONTALIS 'PLUMOSA COMPACTA'	2 GAL.	47
ANTHONY WATERER SPIREA	AS	SPIREA BULMALDA 'ANTHONY WATERER'	3 GAL.	50
WOODWARD ARBORVITAE	WA	THUJA OCCIDENTALIS 'WOODWARDII'	18-24"	42
RED TWIG DOGWOOD	RD	CORNUS ALBA SIBERICA	3-4' B.B.	24
RHEINGOLD ARBORVITAE	RA	THUJA OCCIDENTALIS 'RHEINGOLD'	3 GAL.	16
GOLD MOUND SPIREA	GS	SPIREA BULMALDA 'GOLD MOUND'	2 GAL.	20
PURPLE LEAF SAND CHERRY	PS	PRUNUS CISTENA	3-4'	12

ARCHITECTURE, ENGINEERING & LAND SURVEYING, P.C.
 220 STERLING STREET
 WATERTOWN, NEW YORK, 13600
 TEL (315) 768-3000
 FAX (315) 768-0669
 www.gymo.com




COPYRIGHT © 2010
 ARCHITECTURE, ENGINEERING & LAND SURVEYING, P.C.
 IT IS A VIOLATION OF SECTION 2000, SUBSECTION 2, OF THE NEW YORK STATE EDUCATION LAW FOR ANY PERSON, UNDER ANY COLOR OF LAW, TO EMPLOY OR ENGAGE A LICENSED PROFESSIONAL ENGINEER OR LAND SURVEYOR TO ALTER THIS DOCUMENT IN ANY MANNER. ANY SUCH ALTERATION SHALL APPLY HIS OR HER OATH AND THE NOTATION "SEAL" BE FOLLOWS BY HIS OR HER SIGNATURE, DATE AND A SPECIFIC DESCRIPTION OF ALTERATION.

GENERAL INFORMATION PAGE
 HILTON GARDEN INN/PHASE TWO
 WATERTOWN CITY CENTER PLAZA
 ARSENAL ST/1-81, WATERTOWN, NY

Project No: 2009-215E
 Scale: As Noted
 Date: 2/16/2010
 Drawn By: THR
 Designed By: RGC/PJS
 Checked By:
 Date Issued: 3/9/2010
 Drwg. No.

C001

FOR APPROVALS ONLY
 NOT FOR CONSTRUCTION

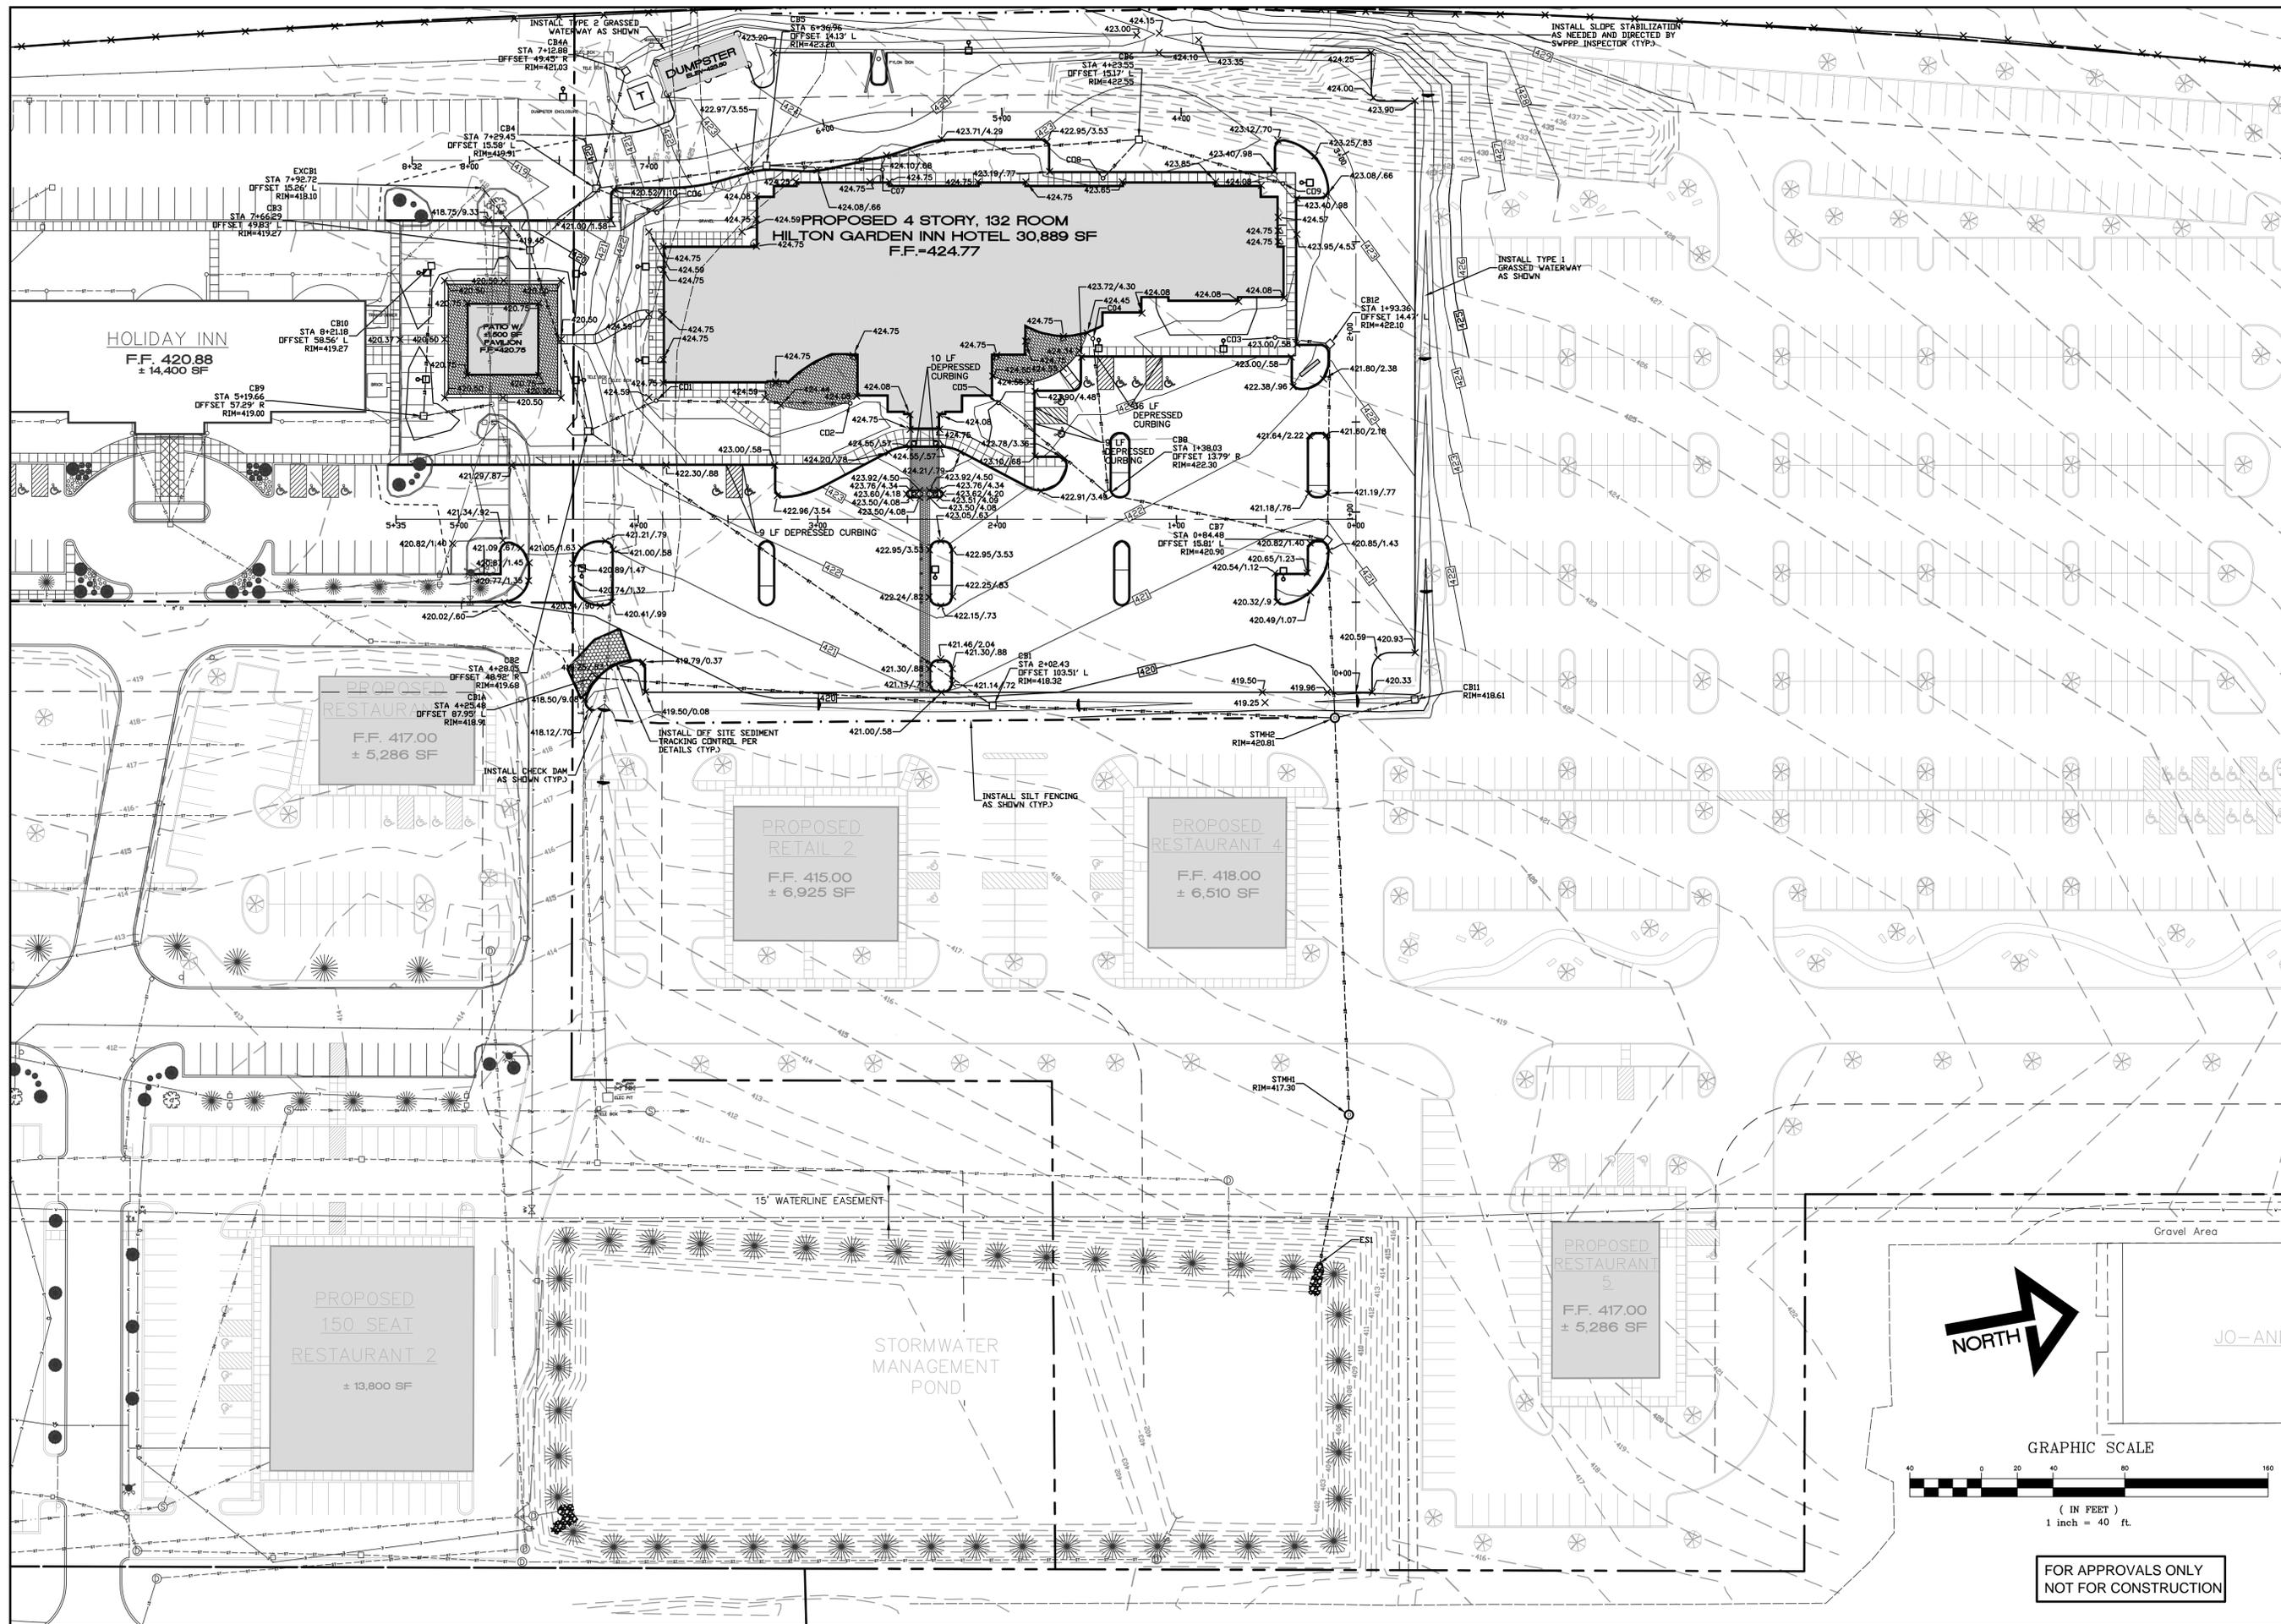

ARCHITECTURE,
ENGINEERING &
LAND SURVEYING
P.C.

220 STERLING STREET
WATERTOWN, NEW YORK, 13001
TEL (518) 788-0800
FAX (518) 788-0808
www.gymo.com



COPYRIGHT © 2010
GYMO
ARCHITECTURE, ENGINEERING
& LAND SURVEYING, P.C.


IT IS A VIOLATION OF SECTION 7209, SUBDIVISION 2, OF THE NEW YORK STATE EDUCATION LAW FOR ANY PERSON, UNLESS ACTING UNDER THE DIRECTION OF A LICENSED PROFESSIONAL ENGINEER OR LAND SURVEYOR TO ALTER THIS DOCUMENT IN ANY WAY. IF ALTERED, SUCH LICENSEE SHALL AFFIX HIS OR HER SEAL AND THE NOTATION "ALTERED BY" FOLLOWED BY HIS OR HER SIGNATURE, DATE AND A SPECIFIC DESCRIPTION OF ALTERATION.

GRADING PLAN


HILTON GARDEN INN/PHASE TWO
WATERTOWN CITY CENTER PLAZA
ARSENAL ST/1-81, WATERTOWN, NY

Project No: 2009-215E
Scale: As Noted
Date: 1/10/10
Drawn By: RGC
Designed By: RGC
Checked By:
Date Issued: 3/9/10
Drwg. No.



C102

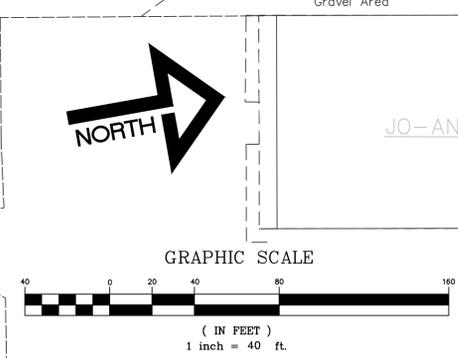

FOR APPROVALS ONLY
NOT FOR CONSTRUCTION

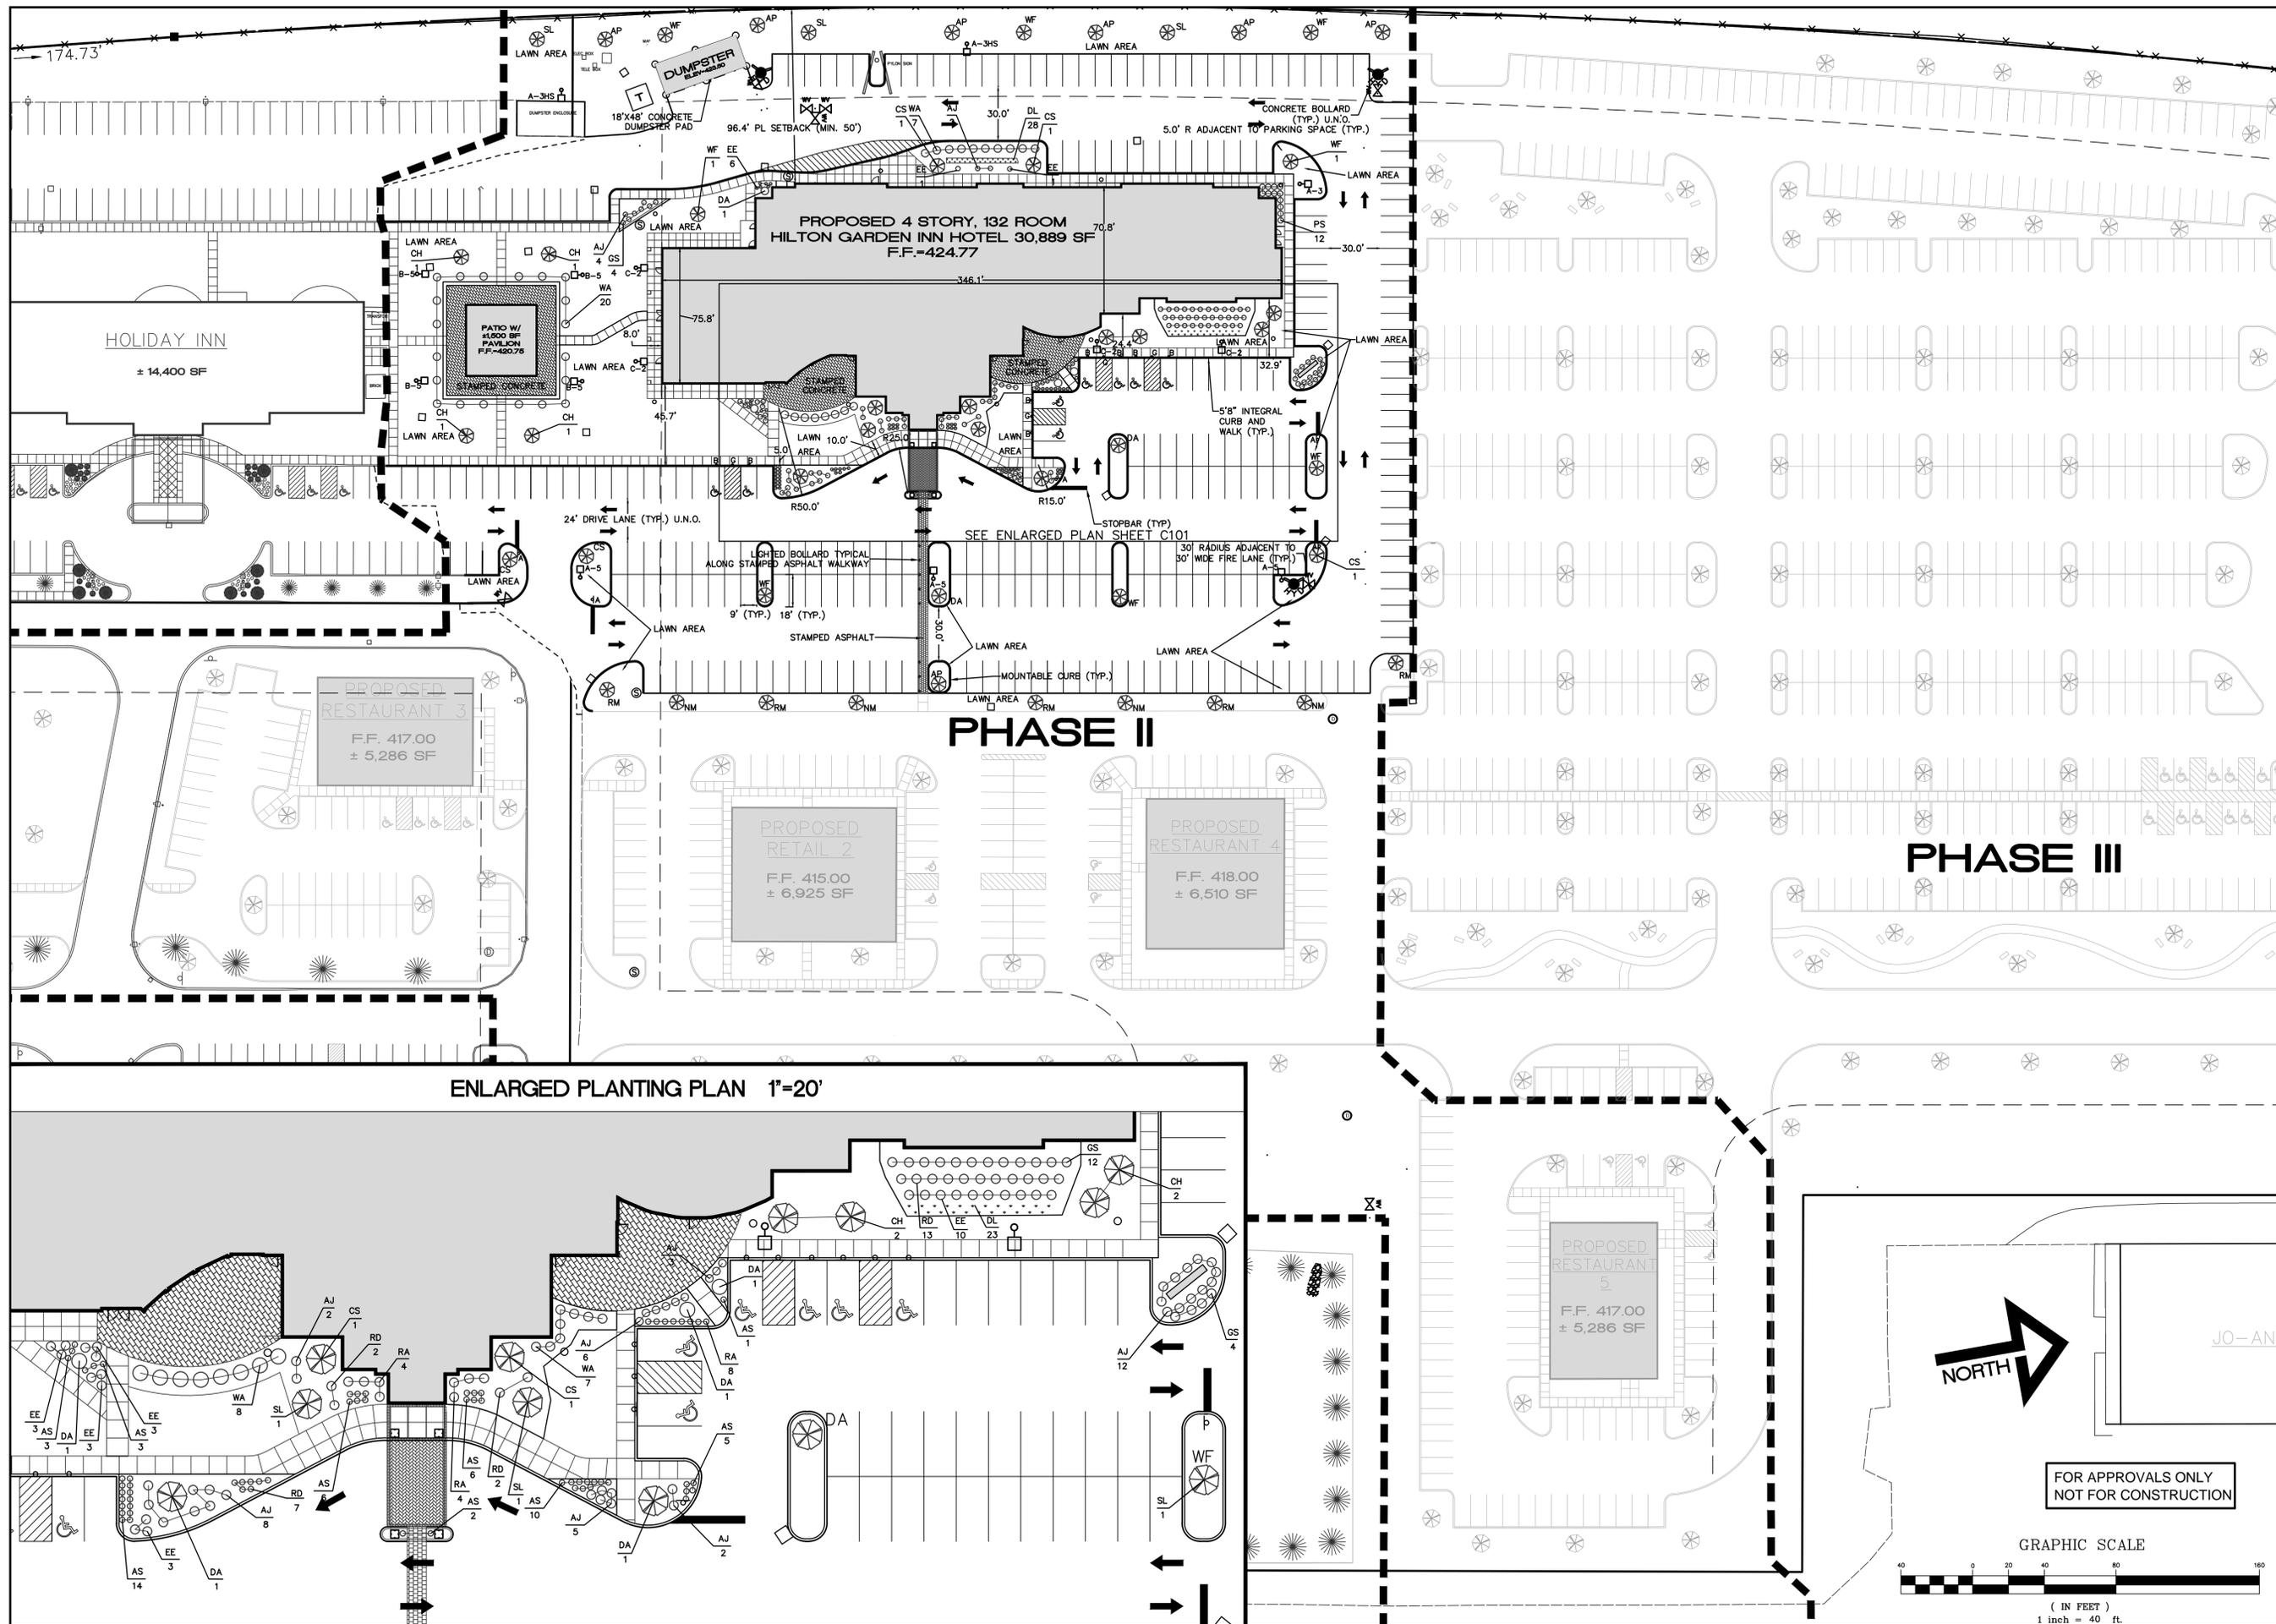

ENLARGED PLANTING PLAN 1"=20'

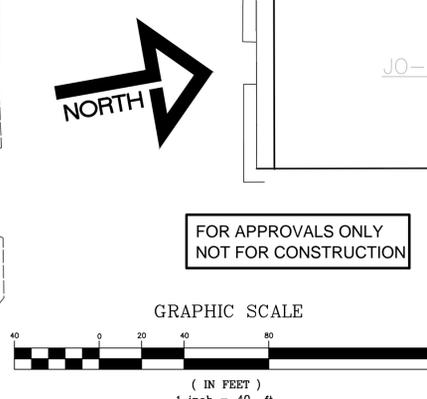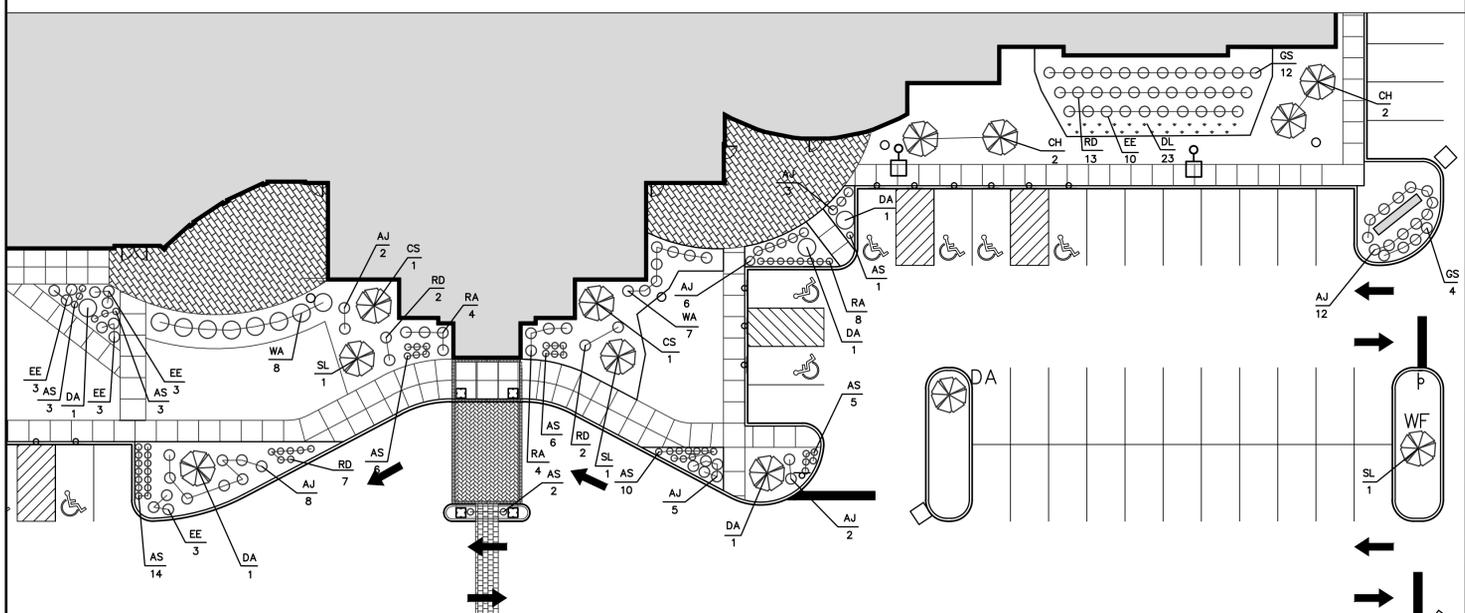

FOR APPROVALS ONLY
NOT FOR CONSTRUCTION

ARCHITECTURE,
ENGINEERING &
LAND SURVEYING
P.C.
220 STERLING STREET
WATERTOWN, NEW YORK, 13001
TEL (518) 788-0800
FAX (518) 788-0808
www.gymo.com



COPYRIGHT © 2010
GYMO
ARCHITECTURE, ENGINEERING
& LAND SURVEYING, P.C.
IT IS A VIOLATION OF SECTION 2000
SUBSECTION 2 OF THE NEW YORK
STATE EDUCATION LAW FOR ANY
PERSON WHOSE ACTS OR OMISSIONS
CONSTITUTE A VIOLATION OF SECTION 2000
OF THE EDUCATION LAW TO REPRODUCE OR
TRANSMIT IN ANY MANNER OR BY ANY
MEANS, ELECTRONIC OR MECHANICAL,
INCLUDING PHOTOCOPYING, RECORDING,
OR BY ANY INFORMATION STORAGE AND
RETRIEVAL SYSTEM, WITHOUT THE
WRITTEN PERMISSION OF GYMO
ARCHITECTURE, ENGINEERING & LAND
SURVEYING, P.C. ANY SUCH REPRODUCTION
OR TRANSMISSION SHALL BE SUBJECT TO
PROSECUTION AND A CIVIL PENALTY OF
UP TO \$500.00 PER PAGE AND A CIVIL
PENALTY OF UP TO \$500.00 PER PAGE
FOR EACH PAGE OF REPRODUCTION OR
TRANSMISSION.

SITE + LANDSCAPING PLAN
HILTON GARDEN INN/PHASE TWO
WATERTOWN CITY CENTER PLAZA
ARSENAL ST/1-81, WATERTOWN, NY

Project No: 2009-215E
Scale: AS NOTED
Date: 12/3/09
Drawn By: RGC
Designed By: RGC
Checked By:
Date Issued: 3/9/10
Drwg. No.

C101

