



GRADING & UTILITY NOTES

- LOCATION OF ALL EXISTING AND PROPOSED SERVICES ARE APPROXIMATE AND MUST BE CONFIRMED INDEPENDENTLY WITH LOCAL UTILITY COMPANIES PRIOR TO COMMENCEMENT OF ANY CONSTRUCTION OR EXCAVATION. SANITARY SEWER AND ALL OTHER UTILITY SERVICE CONNECTION POINTS SHALL BE CONFIRMED INDEPENDENTLY BY THE CONTRACTOR IN FIELD PRIOR TO THE COMMENCEMENT OF CONSTRUCTION. ALL DISCREPANCIES SHALL BE REPORTED IMMEDIATELY IN WRITING TO THE ENGINEER. CONSTRUCTION SHALL COMMENCE BEGINNING AT THE LOWEST INVERT (POINT OF CONNECTION) AND PROGRESS UP GRADIENT. PROPOSED INTERFACE POINTS (CROSSINGS) WITH EXISTING UNDERGROUND UTILITIES SHALL BE FIELD VERIFIED BY TEST PIT PRIOR TO COMMENCEMENT OF CONSTRUCTION.
- ALL UTILITIES AND SERVICES INCLUDING BUT NOT LIMITED TO GAS, WATER, ELECTRIC, SANITARY AND STORM SEWER, TELEPHONE, CABLE, FIBER OPTIC CABLE, ETC. WITHIN THE LIMITS OF DISTURBANCE SHALL BE VERTICALLY AND HORIZONTALLY LOCATED. THE CONTRACTOR SHALL USE AND COMPLY WITH THE REQUIREMENTS OF THE APPLICABLE UTILITY NOTIFICATION SYSTEM TO LOCATE ALL THE UNDERGROUND UTILITIES. THE CONTRACTOR IS RESPONSIBLE FOR REPAIRS OF DAMAGE TO ANY EXISTING UTILITIES DURING CONSTRUCTION AT NO COST TO THE OWNER.
- IT IS THE RESPONSIBILITY OF THE CONTRACTOR TO REVIEW ALL OF THE DRAWINGS AND SPECIFICATIONS ASSOCIATED WITH THE PROJECT WORK SCOPE PRIOR TO THE INITIATION OF CONSTRUCTION. SHOULD THE CONTRACTOR FIND A CONFLICT WITH THE DOCUMENTS RELATIVE TO THE SPECIFICATIONS OR THE RELATIVE CODES, IT IS THE CONTRACTOR'S RESPONSIBILITY TO NOTIFY THE PROJECT ENGINEER OF RECORD IN WRITING PRIOR TO THE START OF CONSTRUCTION. FAILURE BY THE CONTRACTOR TO NOTIFY THE PROJECT ENGINEER SHALL CONSTITUTE ACCEPTANCE OF FULL RESPONSIBILITY BY THE CONTRACTOR TO COMPLETE THE SCOPE OF WORK AS DEFINED BY THE DRAWINGS AND IN FULL COMPLIANCE WITH LOCAL REGULATIONS AND CODES.
- DEFINE AND LOCATE VERTICALLY AND HORIZONTALLY ALL ACTIVE UTILITY AND/OR SERVICE SYSTEMS THAT ARE TO BE REMOVED. THE CONTRACTOR IS RESPONSIBLE TO PROTECT AND MAINTAIN ALL ACTIVE SYSTEMS THAT ARE NOT BEING REMOVED/RELOCATED DURING SITE ACTIVITY.
- THE CONTRACTOR SHALL FAMILIARIZE THEMSELVES WITH THE APPLICABLE UTILITY SERVICE PROVIDER REQUIREMENTS AND IS RESPONSIBLE FOR ALL COORDINATION REGARDING UTILITY DEMOLITION AS IDENTIFIED OR REQUIRED FOR PROJECT. THE CONTRACTOR SHALL PROVIDE THE OWNER WRITTEN NOTIFICATION THAT THE EXISTING UTILITIES AND SERVICES HAVE BEEN TERMINATED AND ABANDONED IN ACCORDANCE WITH JURISDICTION AND UTILITY COMPANY REQUIREMENTS.
- CONTRACTOR IS RESPONSIBLE FOR COORDINATION OF SITE PLAN DOCUMENTS AND ARCHITECTURAL DESIGN FOR EXACT BUILDING UTILITY CONNECTION LOCATIONS, GREASE TRAP REQUIREMENTS/DETAILS, DOOR ACCESS, AND EXTERIOR GRADING. THE UTILITY SERVICE SIZES ARE TO BE DETERMINED BY THE ARCHITECT. THE CONTRACTOR SHALL COORDINATE THE INSTALLATION OF UTILITIES/SERVICES WITH THE INDIVIDUAL COMPANIES, TO AVOID CONFLICTS AND ENSURE PROPER DEPTHS ARE ACHIEVED. THE JURISDICTION UTILITY REQUIREMENTS SHALL ALSO BE MET, AS WELL AS COORDINATING THE UTILITY TIE-INS/CONNECTIONS PRIOR TO CONNECTING TO THE EXISTING UTILITY/SERVICE. WHERE CONFLICTS EXIST WITH THESE SITE PLANS, ENGINEER IS TO BE NOTIFIED PRIOR TO CONSTRUCTION TO RESOLVE SAME.
- WATER SERVICE MATERIALS, BURIAL DEPTH, AND COVER REQUIREMENTS SHALL BE SPECIFIED BY THE LOCAL UTILITY COMPANY. CONTRACTOR'S PRICE FOR WATER SERVICE SHALL INCLUDE ALL FEES AND APPURTENANCES REQUIRED BY THE UTILITY TO PROVIDE A COMPLETE WORKING SERVICE.
- ALL NEW UTILITIES/SERVICES, INCLUDING ELECTRIC, TELEPHONE, CABLE TV, ETC. ARE TO BE INSTALLED UNDERGROUND. ALL NEW UTILITIES/SERVICES SHALL BE INSTALLED IN ACCORDANCE WITH THE UTILITY/SERVICE PROVIDER INSTALLATION SPECIFICATIONS AND STANDARDS.
- SITE GRADING SHALL BE PERFORMED IN ACCORDANCE WITH THESE PLANS. ALL EXCAVATED OR FILLED AREAS SHALL BE COMPACTED AS OUTLINED IN THE GEOTECHNICAL REPORT. MOISTURE CONTENT AT TIME OF PLACEMENT SHALL BE SUBMITTED IN COMPACTION REPORT PREPARED BY A QUALIFIED GEOTECHNICAL ENGINEER, REGISTERED WITH THE STATE WHERE THE WORK IS PERFORMED, VERIFYING THAT ALL FILLED AREAS AND SUBGRADE AREAS WITHIN THE BUILDING FOOT AREA AND AREAS TO BE PAVED HAVE BEEN COMPACTED IN ACCORDANCE WITH THESE PLANS. SUBBASE MATERIAL FOR SIDEWALKS, CURBS, OR ASPHALT SHALL BE FREE OF ORGANICS AND OTHER UNSUITABLE MATERIALS. SHOULD SUBBASE BE DEEMED UNSUITABLE BY OWNER OR OWNER'S REPRESENTATIVE, SUBBASE IS TO BE REMOVED AND FILLED WITH APPROVED FILL MATERIAL.
- ALL FILL, COMPACTION, AND BACKFILL MATERIALS REQUIRED FOR UTILITY INSTALLATION SHALL BE COORDINATED WITH THE APPLICABLE UTILITY COMPANY SPECIFICATIONS.
- THE CONTRACTOR SHALL COMPLY TO THE FULLEST EXTENT WITH THE LATEST OSHA STANDARDS AND REGULATIONS, OR ANY OTHER AGENCY HAVING JURISDICTION FOR EXCAVATION AND TRENCHING PROCEDURES. THE CONTRACTOR IS RESPONSIBLE FOR DETERMINING THE "MEANS AND METHODS" REQUIRED TO MEET THE INTENT AND PERFORMANCE CRITERIA OF OSHA, AS WELL AS ANY OTHER ENTITY THAT HAS JURISDICTION FOR EXCAVATION AND/OR TRENCHING PROCEDURES.
- PAVEMENT SHALL BE SAW CUT IN STRAIGHT LINES TO THE FULL DEPTH OF THE EXISTING PAVEMENT. ALL DEBRIS FROM REMOVAL OPERATIONS SHALL BE REMOVED FROM THE SITE AT THE TIME OF EXCAVATION. STOCKPILING OF DEBRIS WILL NOT BE PERMITTED.
- THE TOPS OF EXISTING MANHOLES, INLET STRUCTURES, AND SANITARY CLEANOUP TOPS SHALL BE ADJUSTED, IF REQUIRED, TO MATCH PROPOSED GRADES IN ACCORDANCE WITH ALL APPLICABLE STANDARDS.
- THE CONTRACTOR IS RESPONSIBLE FOR VERIFICATION OF EXISTING TOPOGRAPHIC INFORMATION AND UTILITY INVERT ELEVATIONS PRIOR TO COMMENCEMENT OF ANY CONSTRUCTION. CONTRACTOR TO ENSURE 0.75% MINIMUM SLOPE AGAINST ALL ISLANDS, OUTLETS, AND CURBS; 1.0% ON ALL CONCRETE SURFACES; AND 1.5% MINIMUM ON ASPHALT, TO PREVENT PONDING. ANY DISCREPANCIES THAT MAY AFFECT THE PUBLIC SAFETY OR PROJECT COST MUST BE IDENTIFIED TO THE ENGINEER IN WRITING IMMEDIATELY. PROCEEDING WITH CONSTRUCTION WITHOUT NOTIFICATION IS DONE SO AT THE CONTRACTOR'S OWN RISK.
- PROPOSED TOP OF CURB ELEVATIONS ARE GENERALLY 6" ABOVE EXISTING LOCAL ASPHALT GRADE UNLESS OTHERWISE NOTED. FIELD ADJUST TO CREATE A MINIMUM OF 0.75% GUTTER GRADE ALONG CURB FACE. ENGINEER TO APPROVE FINAL CURBING CUT SHEETS PRIOR TO INSTALLATION.
- REFER TO SITE PLAN FOR ADDITIONAL NOTES.
- IN CASE OF DISCREPANCIES BETWEEN PLANS OR RELATIVE TO OTHER PLANS, THE SITE PLAN WILL TAKE PRECEDENCE. IMMEDIATELY NOTIFY THE ENGINEER IN WRITING OF ANY CONFLICTS.
- CONTRACTOR SHALL BE REQUIRED TO SECURE ALL NECESSARY PERMITS AND APPROVALS FOR ALL OFF-SITE MATERIAL SOURCES AND DISPOSAL FACILITIES. CONTRACTOR SHALL SUPPLY A COPY OF APPROVALS TO ENGINEER AND OWNER PRIOR TO INITIATING WORK.

GENERAL GRADING & DRAINAGE LEGEND

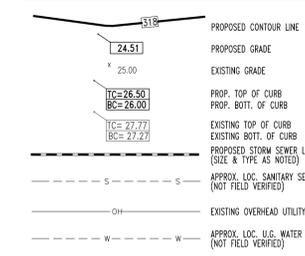

GRAPHIC SCALE

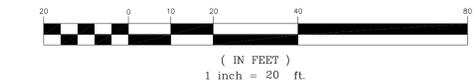

PLAN SCALE: 1"=20'

STREET ADDRESS
1809 STATE STREET

CITY STATE
WATERTOWN NEW YORK

COUNTY
JEFFERSON


REGIONAL DWG. NO

PLAN DESCRIPTION
GRADING PLAN

CAD FILE: B090177SS1

PLAN APPROVALS		DATE	SIGNATURE (2 REQUIRED)	REGIONAL MGR.	CONST. MGR.	OPERATIONS DEPT.	REAL ESTATE DEPT.	CONTRACTOR	OWNER
CO-SIGN SIGNATURES									
FINAL PLAN SIGNATURES									
P.M.									
G.C.									
O/O									
BY									
DATE									
DESCRIPTION									
ISSUE REF									

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 OFFICE 3025 CHEMICAL RD. SUITE 100
 ADDRESS PLYMOUTH MEETING, PA 19462 (484) 530-6773

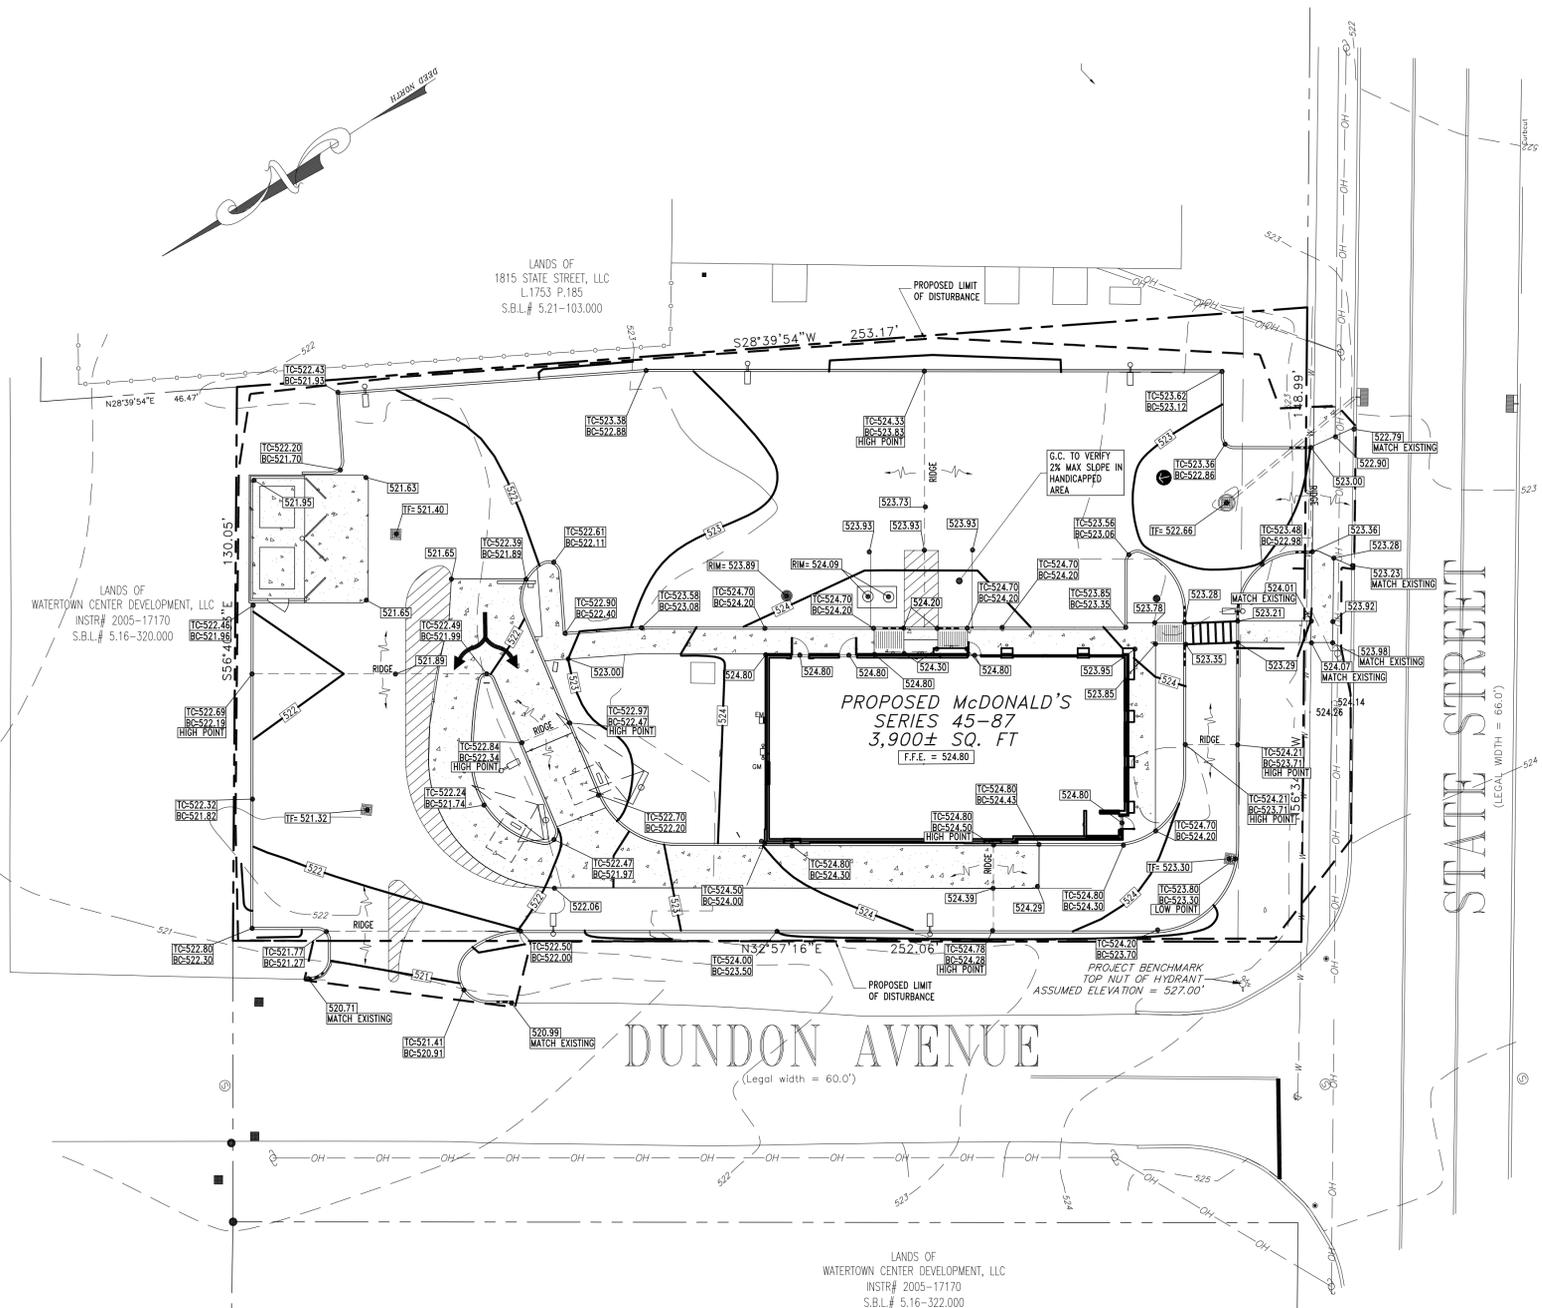

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 PROFESSIONAL ENGINEER
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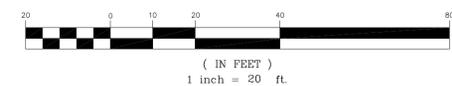
UTILITY NOTES

- CONTRACTOR IS RESPONSIBLE FOR VERIFICATION OF EXISTING TOPOGRAPHY INFORMATION AND UTILITY INVERT ELEVATIONS PRIOR TO COMMENCEMENT OF ANY CONSTRUCTION. CONTRACTOR TO ENSURE 1.5% MIN. ACROSS ALL PAVED SURFACES AND SLOPE ALONG ALL GUTTERS TO PREVENT PONDING. THE CONTRACTOR IS RESPONSIBLE FOR IDENTIFYING ALL DISCREPANCIES AND OTHER CONDITIONS THAT MAY AFFECT PUBLIC SAFETY AS WELL AS THE PROJECT COST TO THE ENGINEER IMMEDIATELY IN WRITING.
- LOCATION OF ALL EXISTING AND PROPOSED SERVICES ARE APPROXIMATE AND MUST BE CONFIRMED INDEPENDENTLY WITH LOCAL UTILITY COMPANIES PRIOR TO COMMENCEMENT OF ANY CONSTRUCTION OR EXCAVATION. SANITARY SEWER AND ALL OTHER UTILITY SERVICE CONNECTION POINTS SHALL BE CONFIRMED INDEPENDENTLY BY THE CONTRACTOR IN FIELD PRIOR TO THE COMMENCEMENT OF CONSTRUCTION. ALL DISCREPANCIES SHALL BE REPORTED IMMEDIATELY IN WRITING TO THE ENGINEER. CONSTRUCTION SHALL COMMENCE BEGINNING AT THE LOWEST INVERT (POINT OF CONNECTION) AND PROGRESS UP GRADIENT. INTERFACE POINTS (CROSSINGS) WITH EXISTING UNDERGROUND INSTALLATIONS SHALL BE FIELD VERIFIED BY TEST PIT PRIOR TO COMMENCEMENT OF CONSTRUCTION. A MINIMUM OF 15" VERTICAL CLEARANCE SHALL BE MAINTAINED BETWEEN ALL UTILITY CROSSINGS. ANY POTENTIAL CROSSINGS LESS THAN THE MINIMUM REQUIRED SHALL BE REPORTED TO THE ENGINEER IMMEDIATELY IN WRITING.
- PROPOSED TOP OF CURB ELEVATIONS TO BE GENERALLY 6" ABOVE EXISTING LOCAL ASPHALT GRADE. FIELD ADJUST TO CREATE A MIN OF 1.5% GUTTER GRADE ALONG CURB FACE. ENGINEER TO APPROVE FINAL CURBING CUT SHEETS PRIOR TO INSTALLATION.
- REFER TO SITE PLAN (SHEET #1) FOR ADDITIONAL NOTES.
- REFER TO CONSTRUCTION DETAILS PLAN FOR GRADING AND YARD DETAILS.
- IN CASE OF DISCREPANCIES BETWEEN PLANS, THE SITE PLAN WILL SUPERSEDE IN ALL CASES. NOTIFY ENGINEER OF RECORD OF ANY CONFLICTS.
- ALL SITE WORK INCLUDING CONCRETE MATS AND PAVING SHALL BE CONSTRUCTED IN ACCORDANCE WITH MCDONALD'S CORPORATION SPECIFICATIONS AND THESE PLANS.
- IT SHALL BE THE CONTRACTOR'S RESPONSIBILITY TO NOTIFY "THE NEW YORK ONE CALL SYSTEM" (1-800-962-7962) 48 HOURS PRIOR TO ANY EXCAVATION ON THIS SITE. CONTRACTOR SHALL ALSO NOTIFY LOCAL WATER & SEWER DEPARTMENTS TO MARK OUT THEIR UTILITIES.
- ALL WORK WITHIN THE RIGHT-OF-WAY SHALL BE CONDUCTED IN ACCORDANCE WITH N.Y.S.D.O.T.
- ALL UTILITY CONNECTIONS TO BE MADE IN ACCORDANCE WITH UTILITY COMPANY REQUIREMENTS.
- ALL UTILITY SERVICES TO BE SIZED IN ACCORDANCE WITH ARCHITECTURAL PLANS.

GENERAL UTILITY LEGEND

○ CO	PROPOSED CLEANOUT
○ RD	PROPOSED ROOF DRAIN
— OH —	EXISTING OVERHEAD UTILITY LINE
— ET —	PROPOSED UNDERGROUND ELECTRIC/TELEPHONE LINE
—	APPROX. LOC. SANITARY SERVICE (NOT FIELD VERIFIED)
—	PROPOSED SANITARY SEWER LINE (SIZE & TYPE AS NOTED)
— W —	APPROX. LOC. U.G. WATER LINE (NOT FIELD VERIFIED)
— W —	PROPOSED WATER LINE (SIZE & TYPE AS NOTED)
— G —	APPROX. LOC. U.G. GAS LINE (NOT FIELD VERIFIED)
— G —	PROPOSED GAS LINE
—	APPROX. LOC. STORM SERVICE (NOT FIELD VERIFIED)
—	PROPOSED STORM SEWER LINE (SIZE & TYPE AS NOTED)
☆	EXISTING LIGHTPOLE

GRAPHIC SCALE




CITY WATER NOTE:

ALL WATER MAIN AND SERVICE WORK MUST BE COORDINATED WITH THE CITY OF WATERTOWN WATER DEPARTMENT. THE WATER DEPARTMENT REQUIREMENTS SUPERCEDE ALL OTHER PLANS AND SPECIFICATIONS PROVIDED.

WORK WITHIN CITY MARGIN NOTE:

ALL WORK TO BE PERFORMED WITHIN THE CITY OF WATERTOWN MARGIN WILL REQUIRE SIGN-OFF FROM A PROFESSIONAL ENGINEER, LICENSED AND CURRENTLY REGISTERED TO PRACTICE IN THE STATE OF NEW YORK, THAT THE WORK WAS BUILT ACCORDING TO THE APPROVED SITE PLAN AND APPLICABLE CITY OF WATERTOWN STANDARDS. COMPACTION TESTING WILL BE REQUIRED FOR ALL WORK PERFORMED IN THE CITY OF WATERTOWN MARGIN AND MUST BE SUBMITTED TO THE CITY OF WATERTOWN CODES DEPARTMENT.

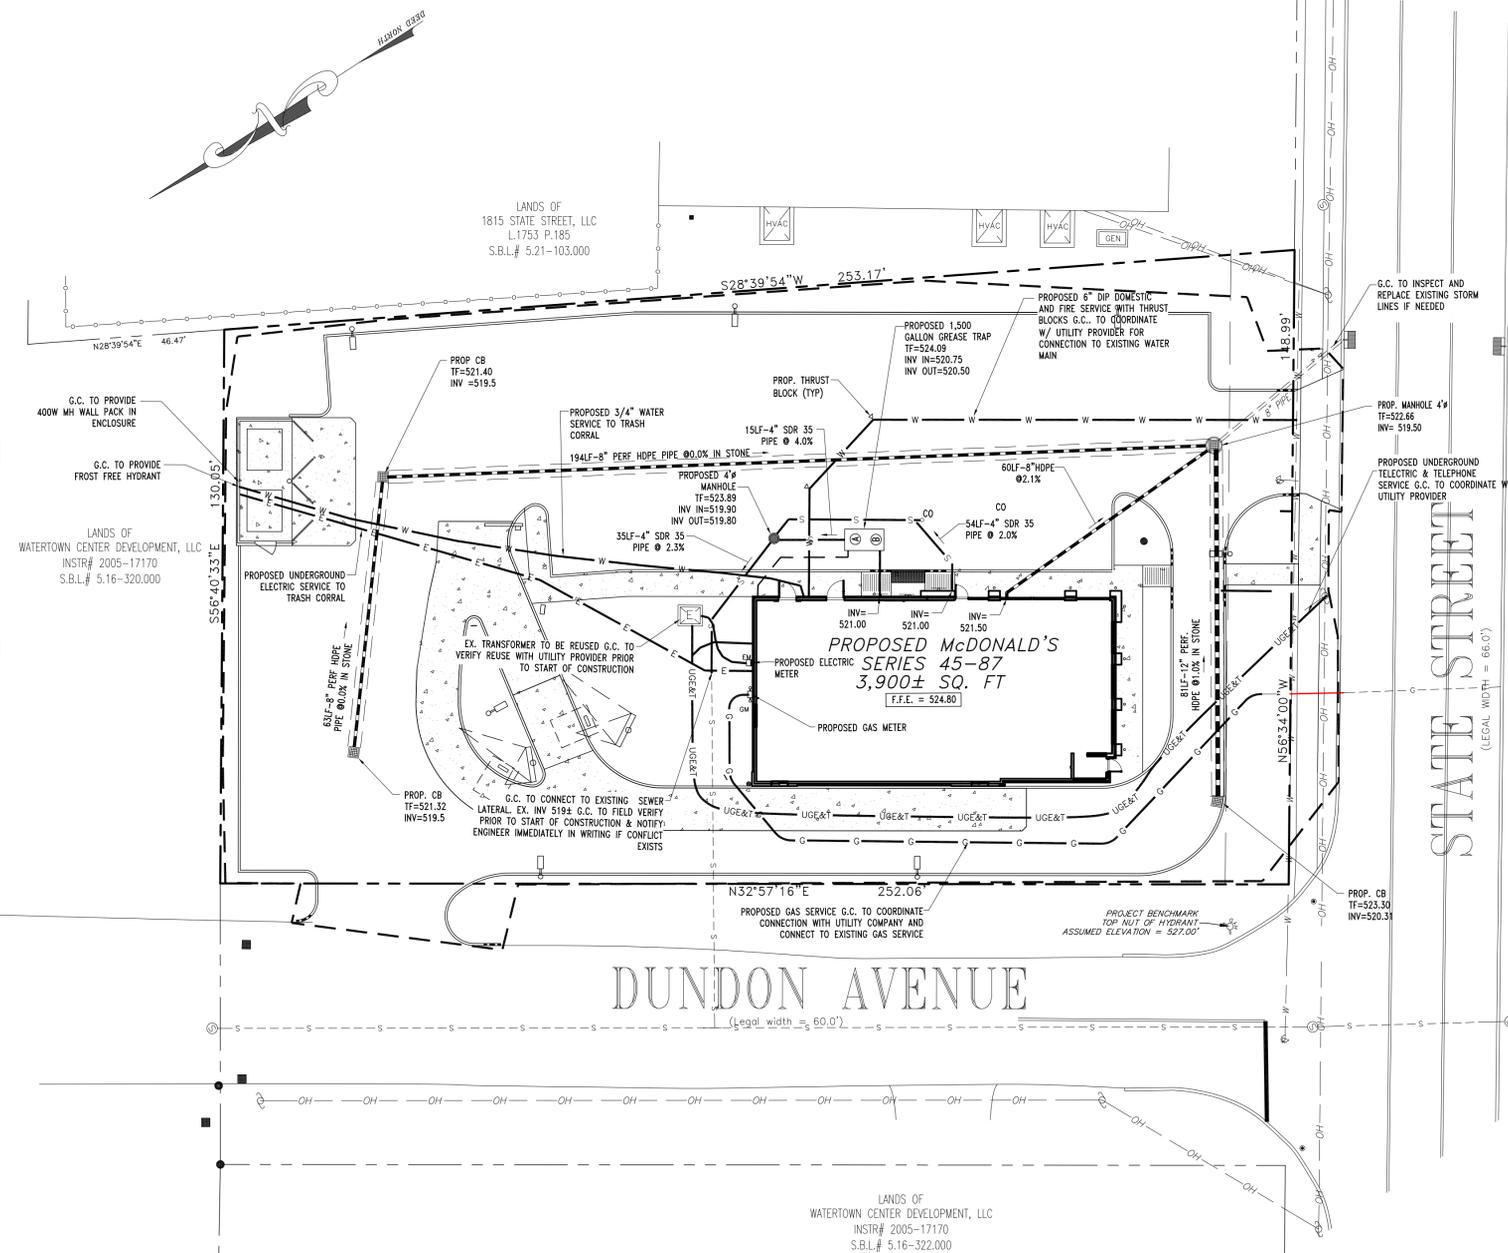

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PLAN SCALE: 1"=20'	
STREET ADDRESS 1809 STATE STREET	
CITY WATERTOWN	STATE NEW YORK
COUNTY JEFFERSON	
REGIONAL DWG. NO	PLAN DESCRIPTION UTILITY AND DRAINAGE PLAN
CAD FILE: B090177SS1	

ISSUE REF	BY	DESCRIPTION	REV	DATE	FINAL PLAN SIGNATURES
					P.M. G.C. O/O

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REGIONAL MGR.	DATE	PLAN APPROVALS
CONST. MGR.	SIGNATURE (2 REQUIRED)	
OPERATIONS DEPT.		
REAL ESTATE DEPT.		
CONTRACTOR	CO-SIGN SIGNATURES	
OWNER		


STATUS	DATE	BY
PRELIMINARY	10-30-09	SG
PLAN CHECKED		OKS
AS-BUILT		

C-3
4 OF 11




LANDSCAPE SCHEDULE

KEY	QTY	BOTANICAL NAME	COMMON NAME	SIZE	REMARKS
SHADE TREE					
ARAF	2	ACER RUBRUM 'AUTUMN FLAME'	AUTUMN FLAME RED MAPLE	2 1/2-3" CAL.	B+B
GTIK	1	GLEDITSIA TRIACANTHOS INTERMIS 'SKYCOLE'	SKYLINE THORNLESS HONEYLOCUST	2 1/2-3" CAL.	B+B
ORNAMENTAL TREE					
BP	1	BETULA PENDULA	EUROPEAN WHITE BIRCH	12-14'	B+B
EVERGREEN SHRUB					
IGC	21	ILEX GLABRA COMPACTA	DWARF INKBERRY HOLLY	24-30"	#5 CAN
JPCP	5	JUNIPERUS CHINENSIS 'PITZERIANA COMPACTA'	COMPACT PITZER JUNIPER	18-24" SPRD.	#3 CAN
RM	3	RHOODODENDRON MAXIMUM 'ROSEBAY'	ROSEBAY RHOODODENDRON	4-5'	B+B
RPJM	8	RHOODODENDRON CAROLINIANA X P.J.M.	P.J.M. RHOODODENDRON	24-30"	B+B
TH	19	TAXUS MEDIA 'HICKSII'	HICKS YEW	30-36"	B+B
TMD	3	TAXUS X MEDIA 'DENSIFORMIS'	DENSIFORMIS YEW	24-30"	B+B
TOT	13	THUJA OCCIDENTALIS 'TECHNY'	TECHNY ARBORVITAE	5-6'	B+B
	72				
DECIDUOUS SHRUB					
PFA	4	POTENTILLA FRUTICOSA 'ABBOTSWOOD'	ABBOTSWOOD CINQUEFOIL	18-24"	#3 CAN
PFD	10	POTENTILLA FRUTICOSA 'GOLD DROP'	GOLD DROP CINQUEFOIL	15-18"	#3 CAN
SJP	6	SPIREA JAPONICA 'LITTLE PRINCESS'	LITTLE PRINCESS SPIREA	15-18"	#3 CAN
VD	3	VIBURNUM DENTATUM	ARROWWOOD VIBURNUM	3-4'	B+B
	25				
PERENNIAL					
HSD	64	HEMEROCALLIS 'STELLA D'ORO'	STELLA D'ORO DAYLILY	1 GAL.	CONTAINER

NOTE: IF ANY DISCREPANCIES OCCUR BETWEEN AMOUNTS SHOWN IN THE PLAN AND THE PLANT LIST, THE PLAN SHALL DICATE.


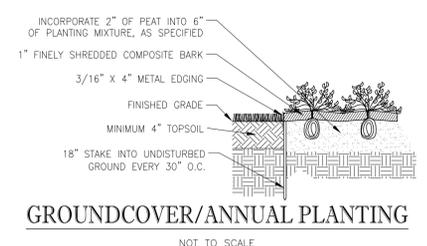


- NOTES:
- NO SOIL OR MULCH SHALL BE PLACED AGAINST ROOT COLLAR OF PLANT.
 - REMOVE ALL ROPE FROM TRUNK & TOP OF ROOT BALL. FOLD BURLAP BACK 1/3 FROM TOP OF ROOT BALL.
 - PLANTING DEPTH SHALL BE THE SAME AS GROWN IN NURSERY.
 - THOROUGHLY SOAK THE TREE ROOT BALL AND ADJACENT PREPARED SOIL SEVERAL TIMES DURING THE FIRST MONTH AFTER PLANTING AND REGULARLY THROUGHOUT THE FOLLOWING TWO SUMMERS.
 - THE BOTTOM OF PLANTING PIT EXCAVATIONS SHOULD BE ROUGH TO AVOID MATTING OF SOIL LAYERS AS NEW SOIL IS ADDED. IT IS PREFERABLE TO TILL THE FIRST LIFT (2-3 IN.) OF PLANTING SOIL INTO THE SUBSOIL.

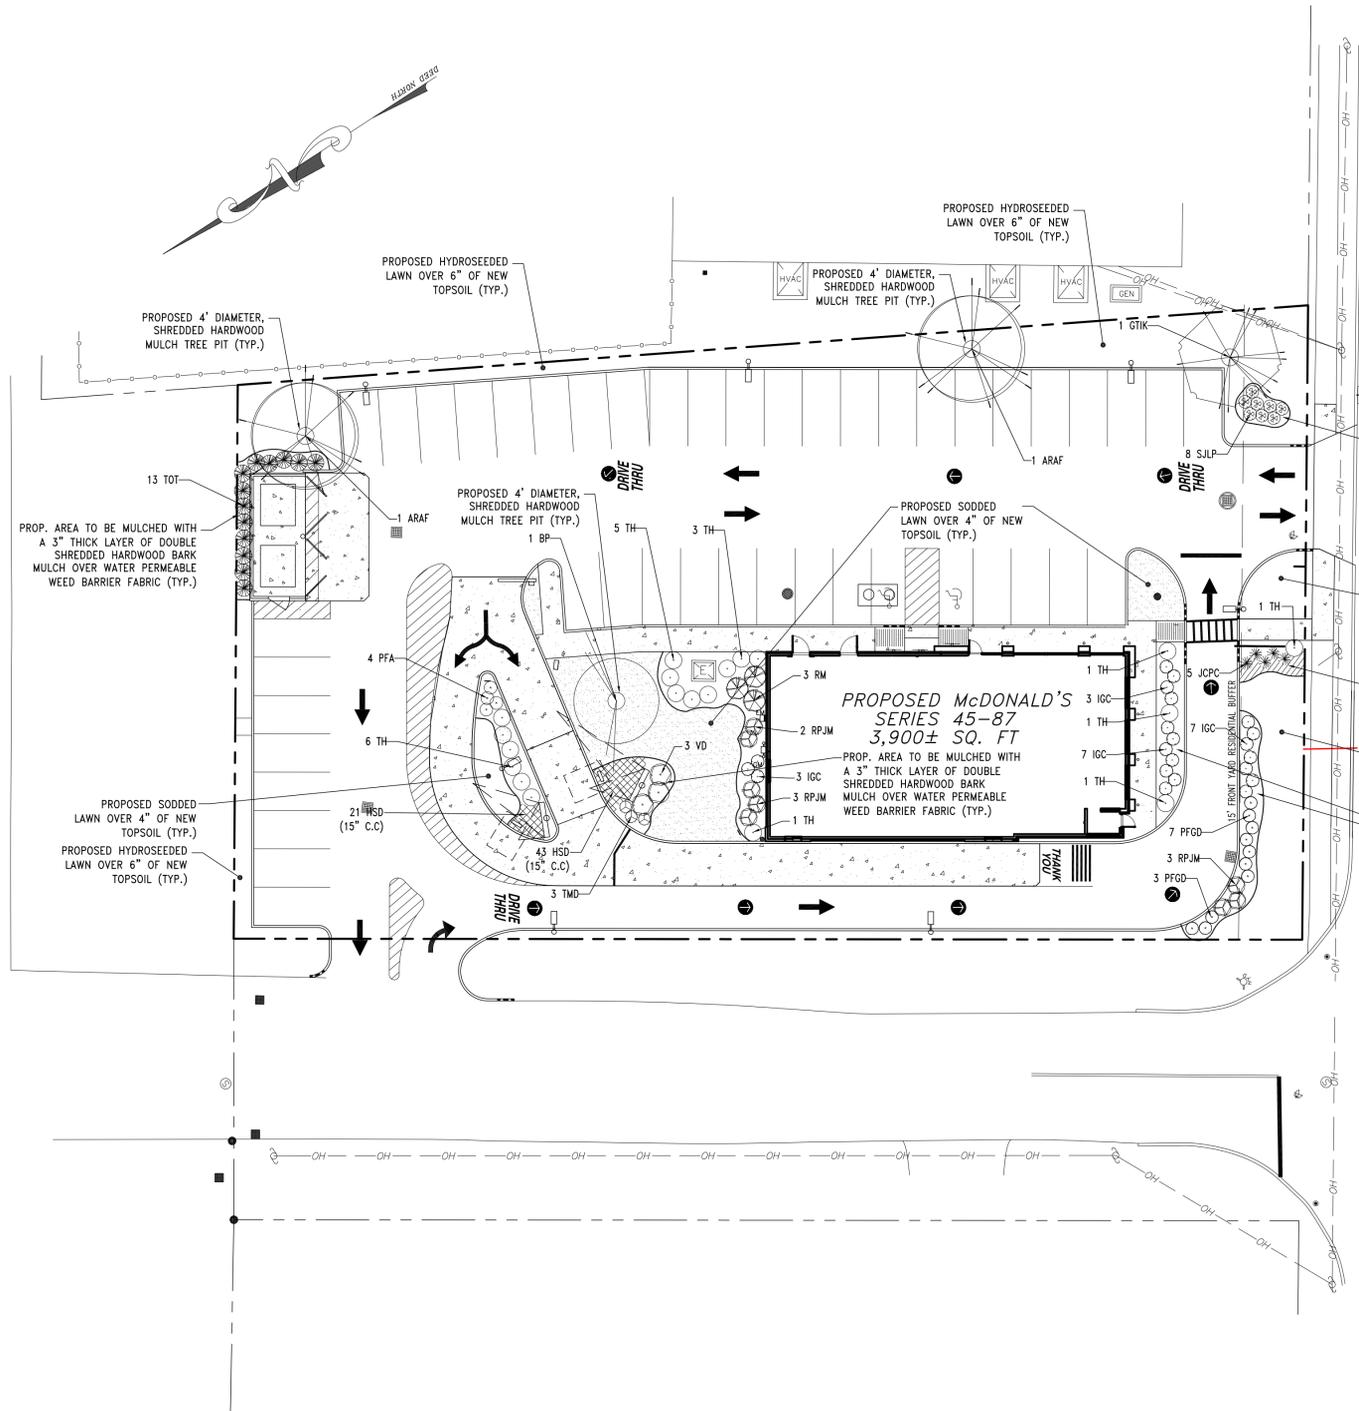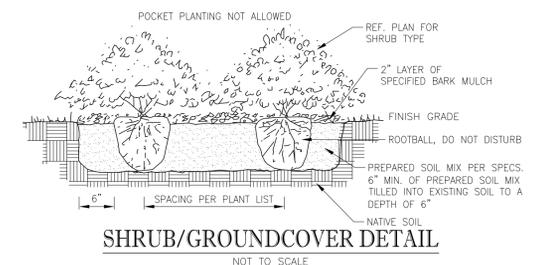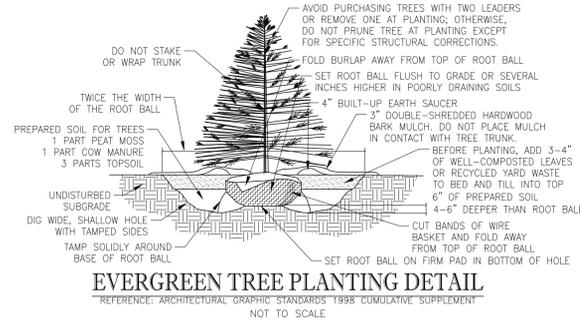

THIS PLAN TO BE UTILIZED FOR LANDSCAPE PURPOSES ONLY

REFERENCE DETAIL SHEET FOR PLANTING SPECIFICATIONS

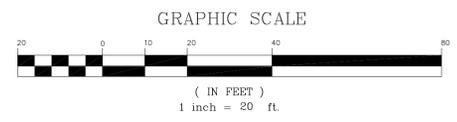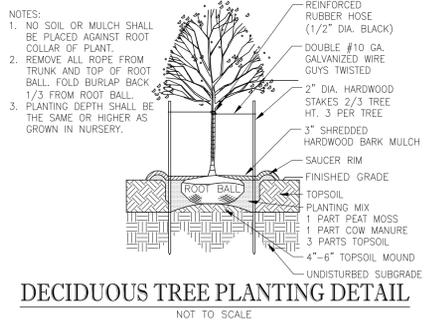

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PLAN SCALE: 1"=20'	
STREET ADDRESS 1809 STATE STREET	
CITY WATERTOWN	STATE NEW YORK
COUNTY JEFFERSON	
REGIONAL DWG. NO.	PLAN DESCRIPTION
CAD FILE: B090177SS1	LANDSCAPING PLAN

FINAL PLAN SIGNATURES		DATE	DESCRIPTION
P.M.	G.C.	O/O	
McDonald's		OFFICE	CONTRACTOR
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PLYMOUTH MEETING, PA 19462 (484) 530-6773			
REGIONAL MGR.	DATE	STATUS	DATE
CONST. MGR.	SIGNATURE (2 REQUIRED)	PRELIMINARY	10-30-08
OPERATIONS DEPT.		PLAN CHECKED	OKS
REAL ESTATE DEPT.		AS-BUILT	
CO-SIGN SIGNATURES		BY	
		SG	
		OKS	
		C-5	
		6 OF 11	

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McDonald's Restaurant
1809 State St
Watertown, NY

Revision Number	Date
"B"	12/31/09

Drawn By: J.A.J.

Designer: Jim Johns

Reviewed By: Carolyn Johns


Date:	Scale:
12/28/09	1"=40'

Southco Job Number
091212B


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St. Louis, MO 63129
Phone : 314-846-9900 Fax: 314-846-4501
E-MAIL: SouthcoLighting@att.net
Representing: SECURITY LIGHTING, INC. A HUBBELL LIGHTING CO.



MX-SERIES
MX-1000wMH\MX1M24\IX02A99
Mounting Height= 24 feet.
From Pole to Photometric Center= 1.33 feet.
IES Candela File: C:\ACAD\ies\MX1000MH.IES
Initial Lumens per Lamp= 110000.
Light Loss Factor (LLF) = 1.0
Number Poles and Fixtures (7)

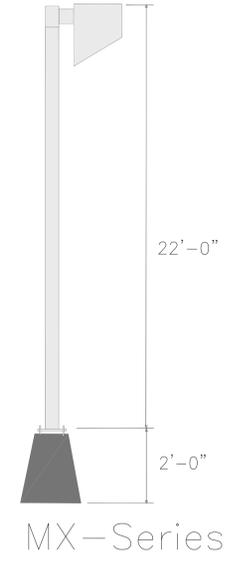

ILLUMINANCE IS IN HORIZONTAL FOOTCANDLES.
TARGET PLANE AT Z = 0 FEET.

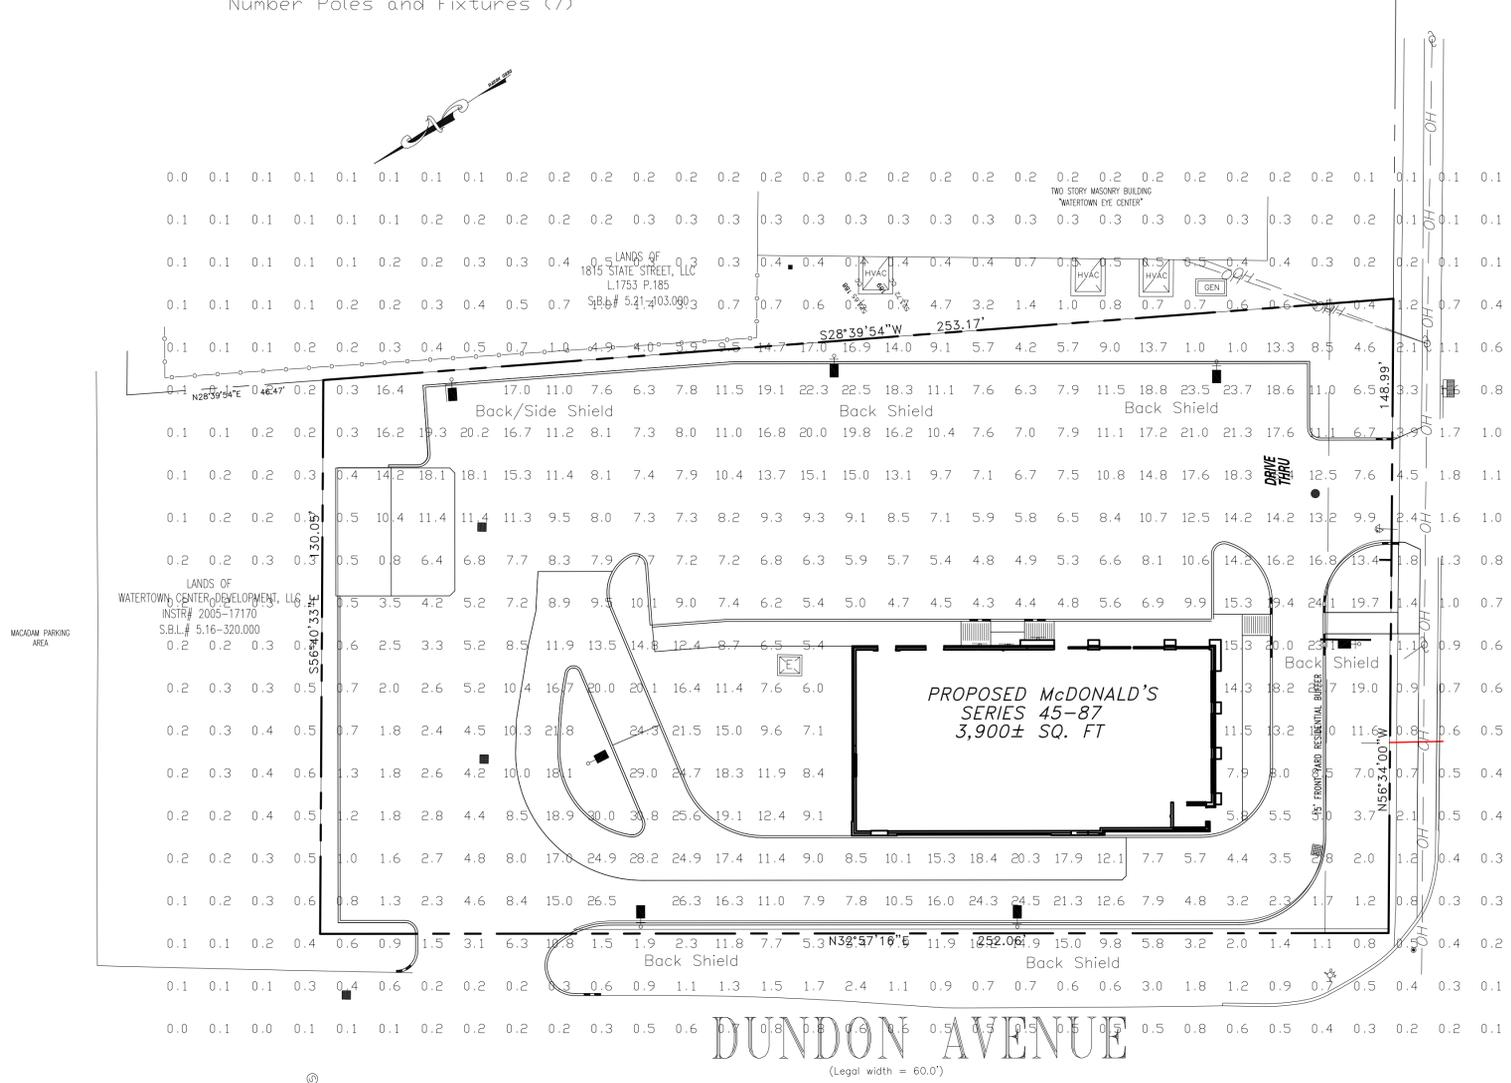Summary	
# POINTS	621
AVERAGE	5.5
MAXIMUM	30.8
MINIMUM	0.0
AVG/MIN	140.85
MAX/MIN	785.28
STD DEV	6.84
CDEF VAR	1.24